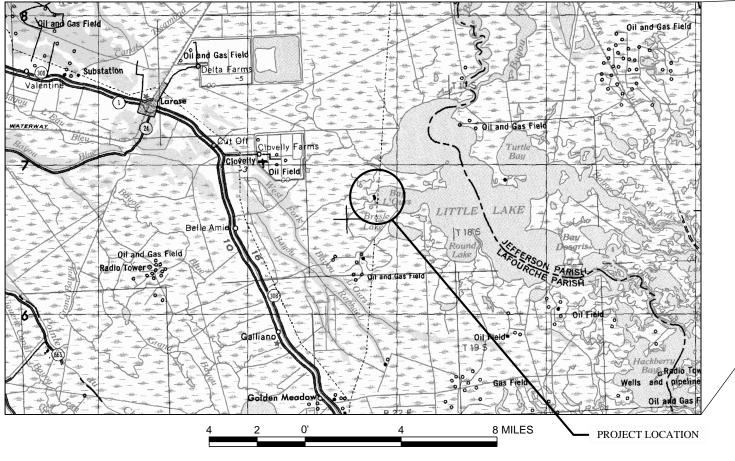
INDEX TO SHEETS

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4	DREDGE TYPICAL SECTION ROCK DIKE A
5	DREDGE TYPICAL SECTION ROCK DIKE B
6	ACCESS DREDGE A
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ION S & QUANTITIES AL SECTION ROCK DIKE A AL SECTION ROCK DIKE B GE B NS A NS B NS C NS D NS F NS G NS H AID DETAILS	STATE OF LOUISIA COASTAL PROTECTION AND RESTO OPERATIONS DIVIS	ORATION AUTHORITY SION OGIC RESTORATION PROJECT A-02		
[8 MILES PROJECT LOCATION	PROF	MES R. SMITH ENSINAL ENGINEER IN TITLE SHEET
		450 LAUREL STREET, SUITE 1200 BATON POLICE LOUISIANA 70801	STATE PROJECT NUMBER: BA-02	
	Stanley Consultants INC.	BATON ROUGE, LOUISIANA 70801	FEDERAL PROJECT NUMBER: BA-02	DATE: NOVEMBER 2015
	REV. DATE DESCRIPTION BY 225 Iowa Avenue, Muscatine, Iowa 52761-3764 www.stanleyconsultants.com	DRAWN BY: SRH DESIGNED BY: SRH	APPROVED BY: JRS	SHEET 1 OF 18

TYPE OF CONSTRUCTION

CLASSIFICATION III HEAVY CONSTRUCTION

GENERAL NOTES

- 1. ALL ELEVATIONS ARE GIVEN IN THE NORTH AMERICAN VERTICAL DATUM ON 1988 (NAVD 88). ALL HORIZONTAL COORDINATES ARE GIVEN IN THE NORTH AMERICAN DATUM OF 1983 (NAD 83).
- 2. THE CONTRACTOR SHALL BE RESPONSIBLE FOR NAVIGATING WITHIN THE LIMITS OF THE PROJECT PLAN AREA. CPRA OR ASSIGNED PROJECT REPRESENTATIVE SHALL MONITOR THE LOCATION DURING CONSTRUCTION.
- THE CONTRACTOR SHALL NOT, AT ANY TIME, TREAD ON EXISTING MARSH OR VEGETATIVE WETLANDS UNLESS OTHERWISE DIRECTED BY THE CPRA PROJECT ENGINEER OR ASSIGNED PROJECT REPRESENTATIVE.
- 4. THE LOCATIONS OF UTILITIES, PIPELINES, AND STRUCTURES SHOWN HEREON HAVE BEEN DETERMINED FROM DATA PROVIDED BY OTHERS. THE ACTUAL LOCATIONS MAY VARY FROM THESE SHOWN AND IT IS POSSIBLE SOME MAY EXIST THAT HAVE NOT BEEN SHOWN. THE CONTRACTOR SHALL BE ON ALERT FOR SUCH UTILITIES, PIPELINES, AND STRUCTURES AND REPORT THEM IMMEDIATELY TO THE CPRA PROJECT ENGINEER OR ASSIGNED PROJECT REPRESENTATIVE. THE CONTRACTOR SHALL VERIFY THE LOCATION OF ALL UTILITIES, PIPELINES, AND STRUCTURES PRIOR TO COMMENCING ANY WORK.
- PRIOR TO FLOATING EQUIPMENT BENEATH ELECTRICAL TRANSMISSION LINES, THE CONTRACTOR SHALL COORDINATE THE DE-ENERGIZING OF POWER LINES. FOR POWER LINES ADJACENT TO LIMITS OF WORK, CONTACT ENTERGY:

JIMMY SHOLAR CELL: 504-615-5540 EMAIL: JSHOLAR@ENTERGY.COM

ENTERGY REQUIRES A MINIMUM 6 WEEK NOTICE TO SCHEDULE DE-ENERGIZING OF POWER LINES. ONCE THE CONTRACT IS AWARDED, THE CONTRACTOR SHALL SUBMIT A SCHEDULE SHOWING WHEN DE-ENERGIZING WILL BE REQUIRED AND CONTACT ENTERGY TO SCHEDULE THESE SERVICE INTERRUPTIONS. DE-ENERGIZING OF POWER LINES ARE FIRST COME, FIRST SERVED AND ARE DEPENDENT ON WEATHER, LOAD REQUIRED, AND OTHER WORK BEING SCHEDULED AND LINES IN THE AREA BEING OUT OF SERVICE. THE CONTRACTOR MAY BE REQUIRED TO ADJUST THE CONSTRUCTION SCHEDULE IF ENTERGY CANNOT GRANT THE REQUESTED SERVICE INTERRUPTIONS.

6. THE CONTRACTOR SHALL BE RESPONSIBLE FOR NOTIFYING PIPELINE OPERATORS 48 HOURS IN ADVANCE OF THE WORK. ALL PIPELINES SHALL BE MARKED WITH BUOYS BY THE CONTRACTOR. THE CONTRACTOR SHALL MAINTAIN BUOYS DURING CONSTRUCTION OR HAVE ADEQUATE NAVIGATIONAL EQUIPMENT ON THE DREDGE TO AVOID DREDGING IN RESTRICTED AREAS. THE CONTRACTOR SHALL NOT ANCHOR OR EXCAVATE WITHIN 50 FEET OF ANY PIPELINE. NOTICE: 48 HOURS BEFORE DREDGING CALL LOUISIANA ONE CALL AT 1-800-272-3020 TO LOCATE ANY OTHER PIPELINES OR UTILITIES.

PIPELINE COMPANIES MAY INCLUDE, BUT ARE NOT LIMITED TO THE FOLLOWING: STONE ENERGY CORPORATION - CONTACT SONNY CROSBY (985) 870-5001

7. THE CONTRACTOR SHALL BE RESPONSIBLE FOR NAVIGATING FROM ACCESS WATER BODIES TO THE PROJECT AREA. DEPENDING ON THE CONTRACTOR'S ACCESS ROUTE TO THE PROJECT AREA, THERE MAY BE OTHER PIPELINES. THE CONTRACTOR SHALL CALL LOUISIANA ONE CALL TO LOCATE PIPELINES AND COORDINATE WITH THE PIPELINES FOR ACCESS.

- 8. VOLUMES SHOWN ARE FOR BIDDING PURPOSES ONLY AND WERE CALCULATED ACCORDING TO CONDITIONS SURVEYED IN 2014. DREDGE CROSS-SECTIONS WILL BE SURVEYED BY THE CONTRACTOR BEFORE AND AFTER FOR BACKFILL VERIFICATION. ALL SURVEYING AND MEASUREMENTS BY THE CONTRACTOR FOR MEASUREMENT AND PAYMENT WILL BE MONITORED BY THE CPRA PROJECT ENGINEER OR ASSIGNED PROJECT REPRESENTATIVE. THE CPRA PROJECT ENGINEER OR ASSIGNED PROJECT REPRESENTATIVE SHALL REVIEW ALL BEFORE AND AFTER SURVEYS, MEASUREMENTS AND PAYMENT CALCULATIONS. IF A DISCREPANCY CANNOT BE RESOLVED, THE CONSTRUCTION MANAGER SHALL PERFORM A CROSS-SECTION SURVEY TO VERIFY THE CONTRACTORS WORK.
- 9. DREDGED MATERIAL SHALL BE PLACED IN AREAS SHOWN ON THE PLANS.
- 10. DREDGED MATERIAL SHALL NOT IMPEDE FLOW OF NATURAL WATERWAYS NOR BE STOCKPILED WHERE NATURAL WATERWAYS INTERSECT CREVASSES.
- 11. CONTRACTOR IS RESPONSIBLE TO VERIFY EXISTING CONDITIONS PRIOR TO COMMENCEMENT OF WORK. ANY OBSERVED DISCREPANCIES BETWEEN PRE-CONSTRUCTION SURVEY AND THE PROJECT PLANS NEED TO BE DOCUMENTED AND PROVIDED TO CPRA PROJECT ENGINEER OR ASSIGNED PROJECT REPRESENTATIVE FOR ACCEPTANCE.
- 12. DISTURBANCE TO MARINE TRAFFIC NEEDS TO BE AVOIDED BY THE CONTRACTOR. NECESSARY WARNING SIGNS/TEMPORARY NAVIGATIONAL AIDS SHALL BE INSTALLED IN ACCORDANCE WITH USCG REGULATIONS. SEQUENCE OF CONSTRUCTION AND PLAN FOR MAINTAINING MARINE TRAFFIC THROUGH THE STRUCTURE SHALL BE SUBMITTED TO CPRA FOR APPROVAL.
- 13. EXISTING ELEVATIONS OF STRUCTURES AND NATURAL GROUND ARE BASED ON SURVEYS CONDUCTED IN 2014. IN AREAS WHERE SURVEY DATA WAS UNAVAILABLE, THE EXISTING CONDITIONS WERE EXTENDED AT THE SAME ELEVATION AS THE LAST MEASURED POINT. THE DRAWINGS INDICATE THE LOCATION OF 2014 AND EXTENDED DATA USED TO DEPICT EXISTING CONDITIONS.
- 14. THE SOUTH COASTAL WETLANDS (SLCW) SECONDARY GPS NETWORK MONUMENT, "BA02SM01 AND/OR BA02SM02, SHALL BE USED FOR HORIZONTAL AND VERTICAL CONTROL. THE DATA SHEET FOR THESE MONUMENTS CAN BE FOUND IN APPENDIX D OF THE SPECIFICATIONS.
- 15. MEAN HIGH WATER AND MEAN LOW WATER DATA BASED UPON 2009 MONITORING DATA PROVIDED BY CPRA.


ITEM No.	ITEM	UNIT	QUANTITY
1	MOBILIZATION AND DEMOBILIZATION	LUMP SUM	1
2	CONSTRUCTION SURVEYS	LUMP SUM	1
3	ACCESS AND FLOATATION CHANNELS	LUMP SUM	1
4	130 LB RIPRAP	TONS	14300
5A	PERMANENT WARNING SIGNS	EACH	13
5B	PERMANENT WARNING SIGNS (SIGNS ONLY)	EACH	5
6	WOVEN GEOTEXTILE FABRIC	SQ YD	11000
7	DE-ENERGIZE POWER LINES	EACH	4

				Stanley Consultants INC. 225 Iowa Avenue, Muscatine, Iowa 52761-3764	OPERATIO 450 LAUREL ST	D RESTORATION AUTHORITY NS DIVISION TREET, SUITE 1200 , LOUISIANA 70801
REV.	DATE	DESCRIPTION	BY	www.stanleyconsultants.com	DRAWN BY: SRH	DESIGNED BY: SRH

SUMMARY OF ESTIMATED QUANTITIES

BASE BID

	E OF LOUIS HES R. SMITH Inse No. 19893 IN IN IN IN IN IN IN IN IN IN IN IN IN
GIWW TO CLOVELLY HYDROLOGIC RESTORATION 2015 MAINTENANCE PROJECT	GENERAL NOTES & QUANTITIES
STATE PROJECT NUMBER: BA-02	a gomminis
FEDERAL PROJECT NUMBER: BA-02	DATE: NOVEMBER 2015
APPROVED BY: JRS	SHEET 2 OF 18

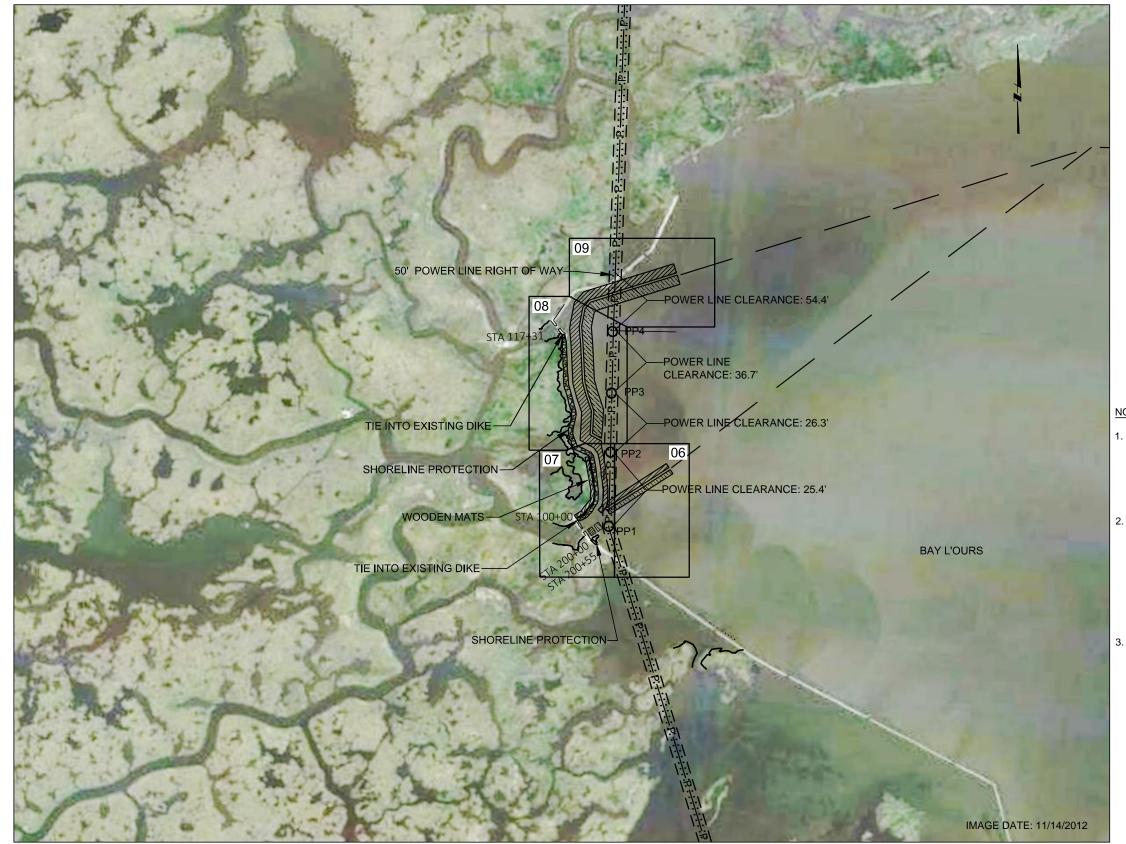

sc	ALE: 1"= 800' (11" X 17")		IMAGE DATE: 11/14/2012	JAN PROFE	EOF LOUIS MES R. SMITH INSE NO. 19893 SSIONAL ENGINEER IN NGINEER
			D RESTORATION AUTHORITY NS DIVISION	GIWW TO CLOVELLY HYDROLOGIC RESTORATION 2015 MAINTENANCE PROJECT	SITE PLAN
+	Stoplay Consultants	450 LAUREL ST	REET, SUITE 1200 , LOUISIANA 70801	STATE PROJECT NUMBER: BA-02	
+	Stanley Consultants INC.	BATON ROUGE	, LOUISIANA 70001	FEDERAL PROJECT NUMBER: BA-02	DATE: NOVEMBER 2015
B١	225 Iowa Avenue, Muscatine, Iowa 52761-3764 www.stanleyconsultants.com	DRAWN BY: SRH	DESIGNED BY: SRH	APPROVED BY: JRS	SHEET 3 OF 18

REV.	DATE	DESCRIPTION	BY

	WOODEN MATS
	PROPOSED SHORELINE PROTECTION
	PROPOSED EXCAVATION AREA
UNNNN	TEMPORARY SPOIL LOCATION
	EXISTING MARSH EDGE
P	POWER LINES
—o—	SURVEYED POWER POLES
	20 FT VERTICAL AND HORIZONTAL CLEARANCE
	50 FT ENTERGY POWER LINE RIGHT OF WAY
<u> </u>	POTENTIAL ACCESS ROUTE (CONTRACTOR TO DETERMINE)

Utility Disposition									
Item	Description	Northing	Easting	Disposition					
PP 1	Wooden Poles (triple)	369083.35'	3631165.86'	Do Not Disturb					
PP 2	Metal Pole	369703.60'	3631177.08'	Do Not Disturb					
PP 3	Metal Pole	370198.75'	3631188.40'	Do Not Disturb					
PP 4	Wooden Poles (double)	3631193.48'	370714.44'	Do Not Disturb					


NOTES:

1. ACCESS ROUTES ARE SHOWN FOR INFORMATIONAL PURPOSES ONLY. ACCESS CHANNELS, OTHER THAN THOSE SHOWN ON THE PLANS MAY BE REQUIRED TO REACH LAKE RIM TO CONSTRUCT PROPOSED SHORELINE PROTECTION. IT IS THE CONTRACTOR'S RESPONSIBILITY TO DETERMINE ACCESS CHANNEL REQUIREMENTS PRIOR TO SUBMITTING BID AND INCLUDE IN BID PRICE.

2. PRIOR TO FLOATING EQUIPMENT BENEATH ELECTRICAL TRANSMISSION LINES, THE CONTRACTOR SHALL COORDINATE THE DE-ENERGIZING OF POWER LINES. FOR POWER LINES ADJACENT TO LIMITS OF WORK, CONTACT ENTERGY:


JIMMY SHOLAR CELL: 504-615-5540 EMAIL: JSHOLAR@ENTERGY.COM SEE NOTE 5 ON SHEET 2 AND SPECIFICATIONS FOR ADDITIONAL INFORMATION ON DE-ENERGIZING ..

3. SEE NOTE 4, 6 AND 7 ON SHEET 2.

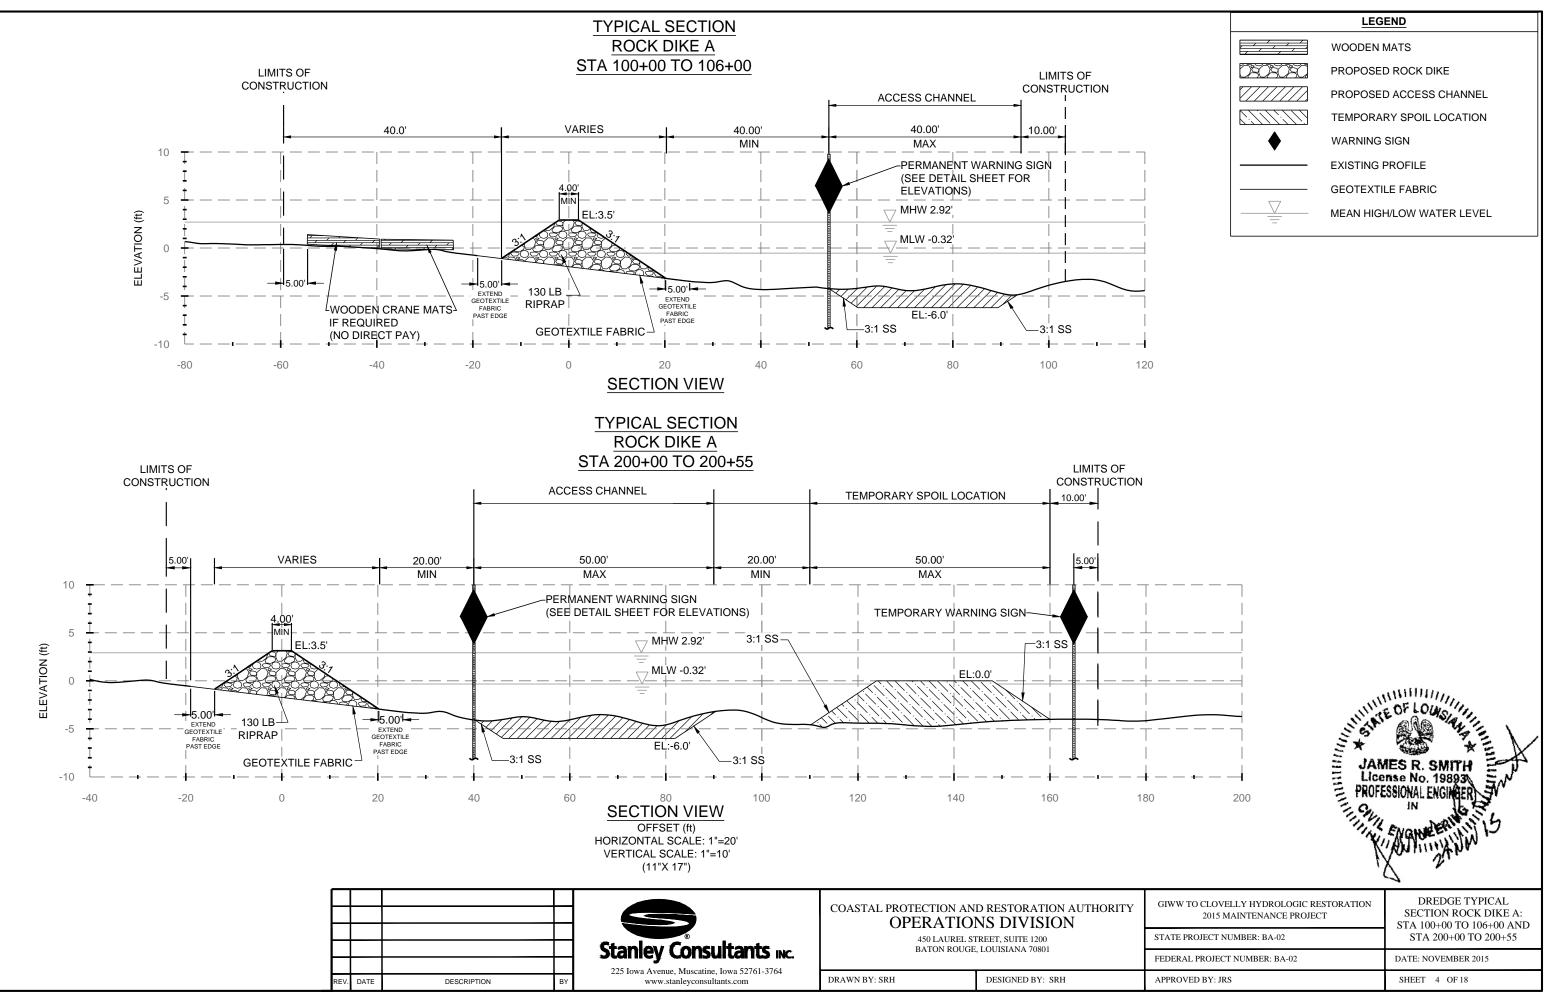



	WOODEN MATS
DRORORO	PROPOSED ROCK DIKE
	PROPOSED ACCESS CHANNEL
	TEMPORARY SPOIL LOCATION
•	WARNING SIGN
	EXISTING PROFILE
	GEOTEXTILE FABRIC
	MEAN HIGH/LOW WATER LEVEL

TYPICAL SECTION ROCK DIKE: STA 106+01 TO 117+31

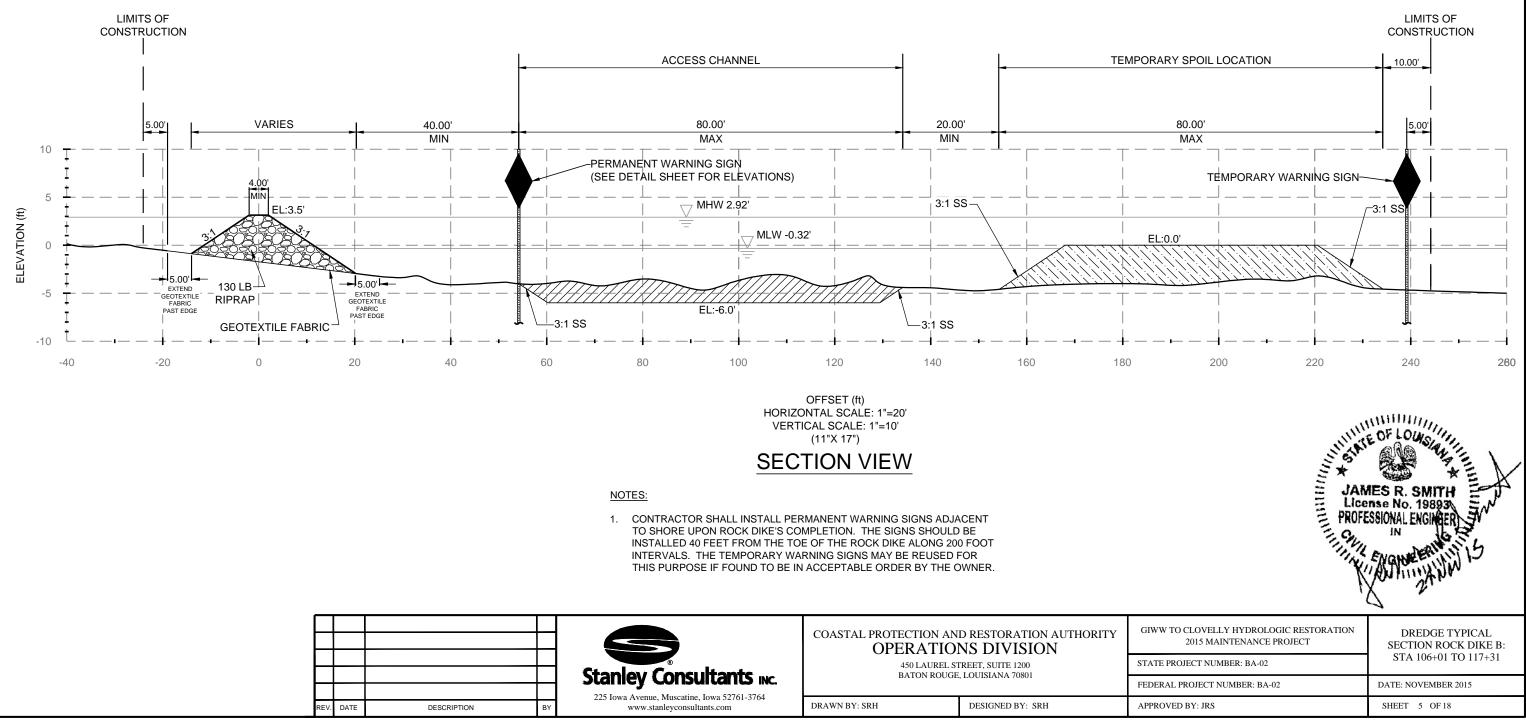


				Stanley Consultants INC.	OPERATIO 450 LAUREL ST	D RESTORATION AUTHORITY NS DIVISION IREET, SUITE 1200 5, LOUISIANA 70801	
RE	V. DATE	DESCRIPTION	BY	225 Iowa Avenue, Muscatine, Iowa 52761-3764 www.stanleyconsultants.com	DRAWN BY: SRH	DESIGNED BY: SRH	Γ

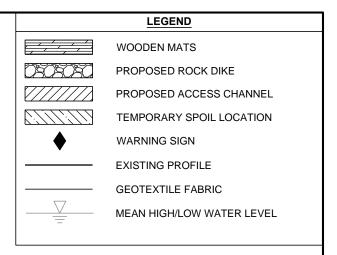

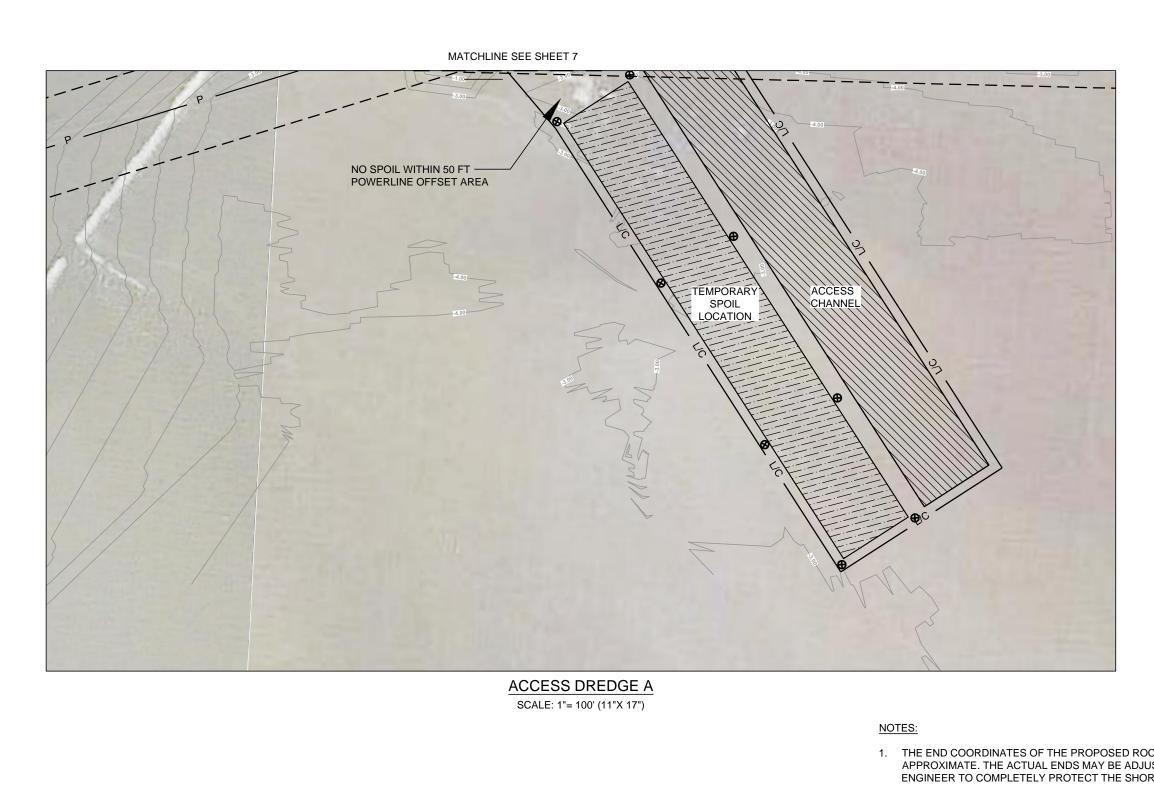

- 2. LOCATIONS OF PERMANENT WARNING SIGNS MAY BE ADJUSTED IN THE FIELD BY ENGINEER.
- 3. SEE SHEET 7 FOR ADDITIONAL ROCK DIKE ALIGNMENT INFORMATION.


				Stanley Consultants INC.	OPERATIO 450 LAUREL ST	D RESTORATION AUTHORITY NS DIVISION FREET, SUITE 1200 C, LOUISIANA 70801
RE	V. DATE	DESCRIPTION	BY	225 Iowa Avenue, Muscatine, Iowa 52761-3764 www.stanleyconsultants.com	DRAWN BY: SRH	DESIGNED BY: SRH

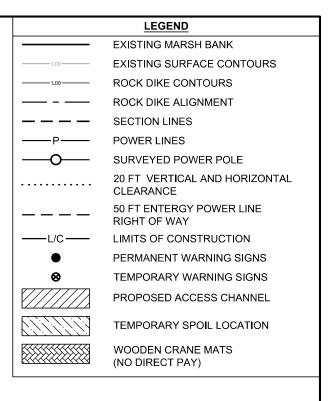

CK DIKES ARE	
ISTED IN FIELD BY	
RE LINE.	

IN TE OF LOW - PK 94 JAMES R. SMITH License No. 19893 PROFESSIONAL ENGINEE

GIWW TO CLOVELLY HYDROLOGIC RESTORATION 2015 MAINTENANCE PROJECT	ACCESS DREDGE A
STATE PROJECT NUMBER: BA-02	
FEDERAL PROJECT NUMBER: BA-02	DATE: NOVEMBER 2015
APPROVED BY: JRS	SHEET 6 OF 18

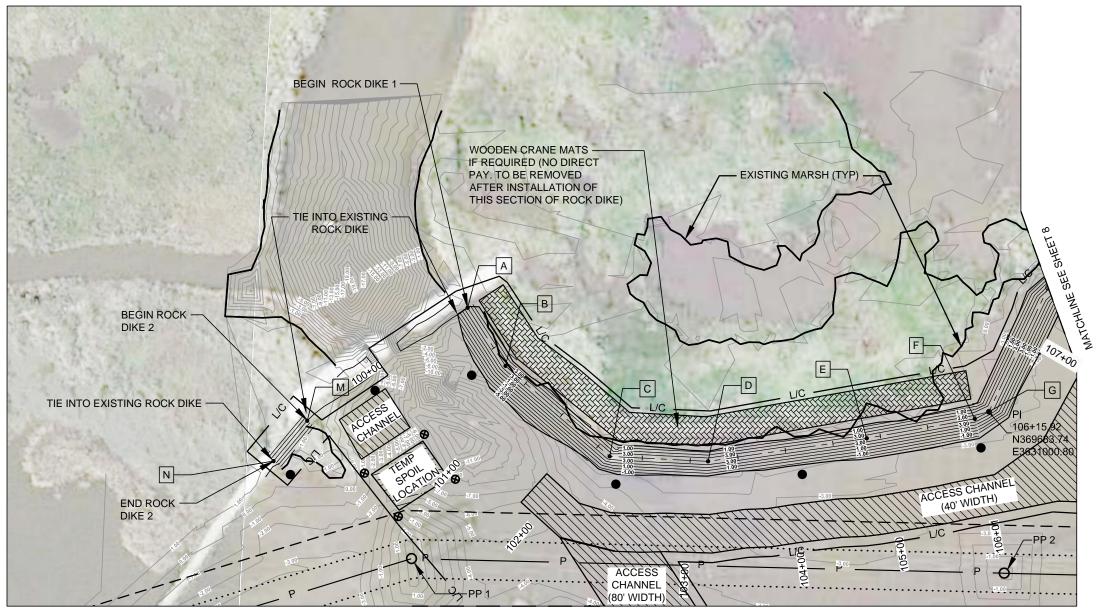

MATCHLINE SEE SHEET 6


PLAN VIEW A

SCALE: 1"= 100' (11"X 17")

NOTES:

- 1. THE END COORDINATES OF THE PROPOSED ROCK DIKES ARE APPROXIMATE. THE ACTUAL ENDS MAY BE ADJUSTED IN FIELD BY ENGINEER TO COMPLETELY PROTECT THE SHORE LINE.
- 2. LOCATIONS OF PERMANENT WARNING SIGNS MAY BE ADJUSTED IN THE FIELD BY ENGINEER.
- 3. SEE SHEET 8 FOR ADDITIONAL ROCK DIKE ALIGNMENT INFORMATION.
- 4. THE CONTRACTOR MAY INSTALL THE DIKE FROM STATION 100+00 TO 106+00 USING EITHER THE ACCESS CHANNEL OR CRANE MATS AT HIS OPTION.
- 5. IF THE POWERLINE CANNOT BE DE-ENERGIZED BETWEEN STATIONS 106+00 AND 117+31 AND STATIONS 200+00 TO 200+55, THE CONTRACTOR SHALL INSTALL THE DIKE USING CRANE MATS.

\square					BATON ROUGE, LOUISIANA 70801		GIWW TO CLOVELLY HYDROLOGIC RESTORATION 2015 MAINTENANCE PROJECT	PLAN VIEW A 100+00 TO 107+00 AND	
_				Stanley Consultants INC.			STATE PROJECT NUMBER: BA-02	200+00 TO 200+55	
				4			FEDERAL PROJECT NUMBER: BA-02	DATE: NOVEMBER 2015	
 REV.	DATE	DESCRIPTION	BY	225 Iowa Avenue, Muscatine, Iowa 52761-3764 www.stanleyconsultants.com	DRAWN BY: SRH	DESIGNED BY: SRH	APPROVED BY: JRS	SHEET 7 OF 18	

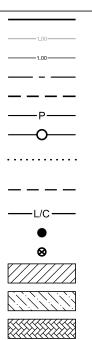



LEGEND EXISTING MARSH BANK EXISTING SURFACE CONTOURS ROCK DIKE CONTOURS ROCK DIKE ALIGNMENT SECTION LINES POWER LINES SURVEYED POWER POLE 20 FT VERTICAL AND HORIZONTAL CLEARANCE 50 FT ENTERGY POWER LINE RIGHT OF WAY LIMITS OF CONSTRUCTION PERMANENT WARNING SIGNS TEMPORARY WARNING SIGNS PROPOSED ACCESS CHANNEL TEMPORARY SPOIL LOCATION

WOODEN CRANE MATS (NO DIRECT PAY)

ROCK DIKE 1 POINT TABLE						
POINT	STATION	NORTHING	EASTING			
A B C D E F	100+00.00	369140.81	3630892.44			
	100+72.29	369180.21	3630953.04			
	102+15.98	369288.73	3631047.23			
	103+18.66	369391.28	3631052.42			
	104+85.62	369556.52	3631028.54			
	106+00.87	369669.91	3631007.92			
G	106+15.92	369683.74	3631000.80			

ROCK DIKE 2 POINT TABLE						
POINT	STATION	NORTHING	EASTING			
М	200+00.00	368973.86	3631009.82			
N	200+54.79	368938.71	3631051.86			

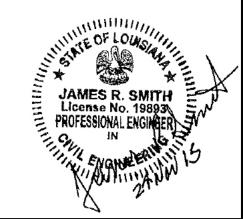

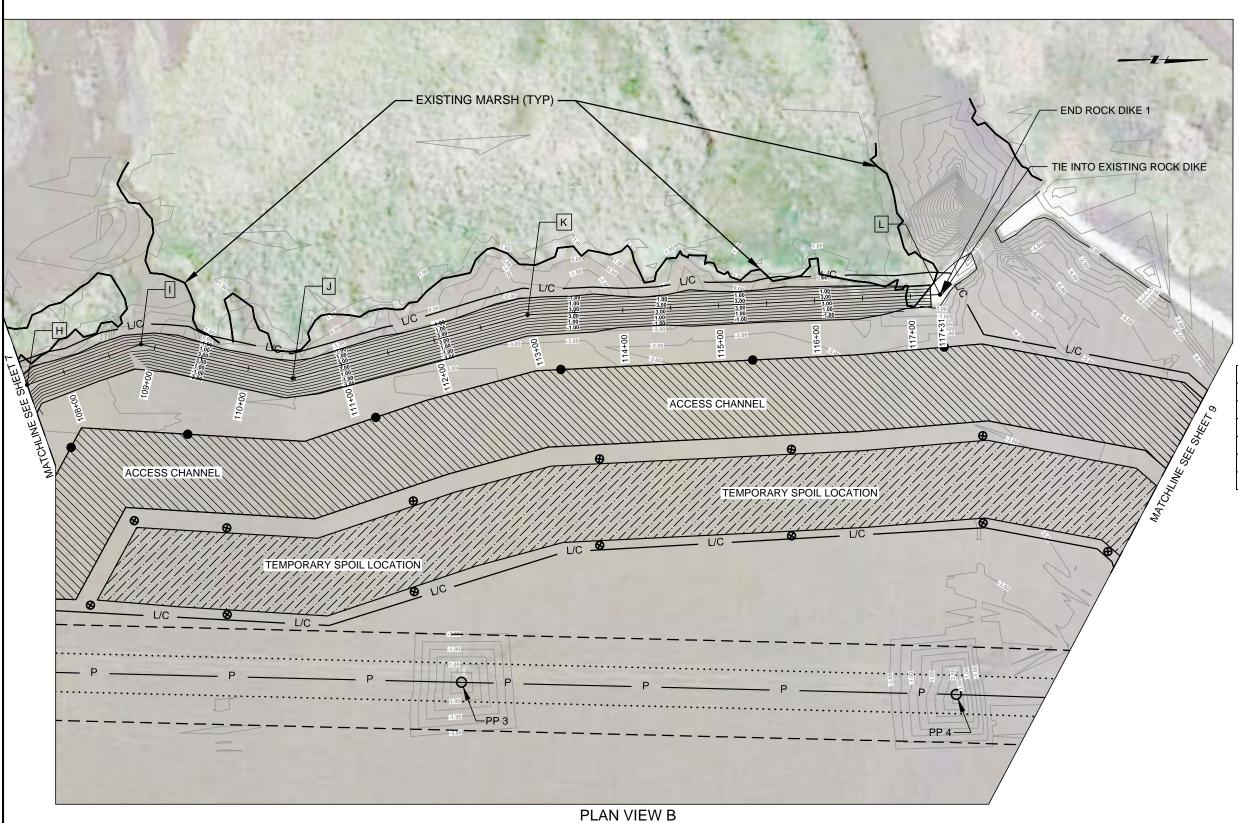

SCALE: 1"= 100' (11"X 17")

NOTES:

- 1. THE END COORDINATES OF THE PROPOSED ROCK DIKES ARE APPROXIMATE. THE ACTUAL ENDS MAY BE ADJUSTED IN FIELD TO COMPLETELY PROTECT THE SHORE LINE.
- 2. LOCATIONS OF PERMANENT WARNING SIGNS MAY BE ADJUSTED IN THE FIELD BY ENGINEER.

DATE DESCRIPTION BY	-
DATE DESCRIPTION BY	www.



	D RESTORATION AUTHORITY	GIWW TO CLOVELLY HYDROLOGIC RESTORATION 2015 MAINTENANCE PROJECT	PLAN VIEW B 107+00 TO 117+31	
450 LAUREL STREET, SUITE 1200 BATON ROUGE, LOUISIANA 70801 DRAWN BY: SRH DESIGNED BY: SRH		STATE PROJECT NUMBER: BA-02		
		FEDERAL PROJECT NUMBER: BA-02	DATE: NOVEMBER 2015	
		APPROVED BY: JRS	SHEET 8 OF 18	


	EXIST
	EXIST
	ROCK
	ROCK
	SECT
—_Р	POWE
—o—	SURV
	20 FT CLEA
	50 FT RIGH
L/C	LIMIT
•	PERM
8	TEMP
	PROP
	TEMP

LEGEND
EXISTING MARSH BANK
EXISTING SURFACE CONTOURS
ROCK DIKE CONTOURS
ROCK DIKE ALIGNMENT
SECTION LINES
POWER LINES
SURVEYED POWER POLE
20 FT VERTICAL AND HORIZONTAL CLEARANCE
50 FT ENTERGY POWER LINE RIGHT OF WAY
LIMITS OF CONSTRUCTION
PERMANENT WARNING SIGNS
TEMPORARY WARNING SIGNS
PROPOSED ACCESS CHANNEL
TEMPORARY SPOIL LOCATION

WOODEN CRANE MATS (NO DIRECT PAY)

ROCK DIKE 1 POINT TABLE (CON'T)							
STATION	NORTHING	EASTING					
107+59.29	369745.49	3630871.41					
108+85.28	369864.16	3630829.09					
110+47.22	370022.17	3630864.54					
113+00.81	370266.97	3630798.35					
117+30.85	370696.50	3630777.23					
	STATION 107+59.29 108+85.28 110+47.22 113+00.81	STATION NORTHING 107+59.29 369745.49 108+85.28 369864.16 110+47.22 370022.17 113+00.81 370266.97					

JAMES R. SMITH License No. 19893 PROFESSIONAL ENGINEER
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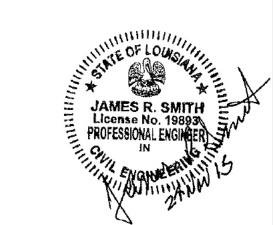
SCALE: 1"= 100' (11"X 17")

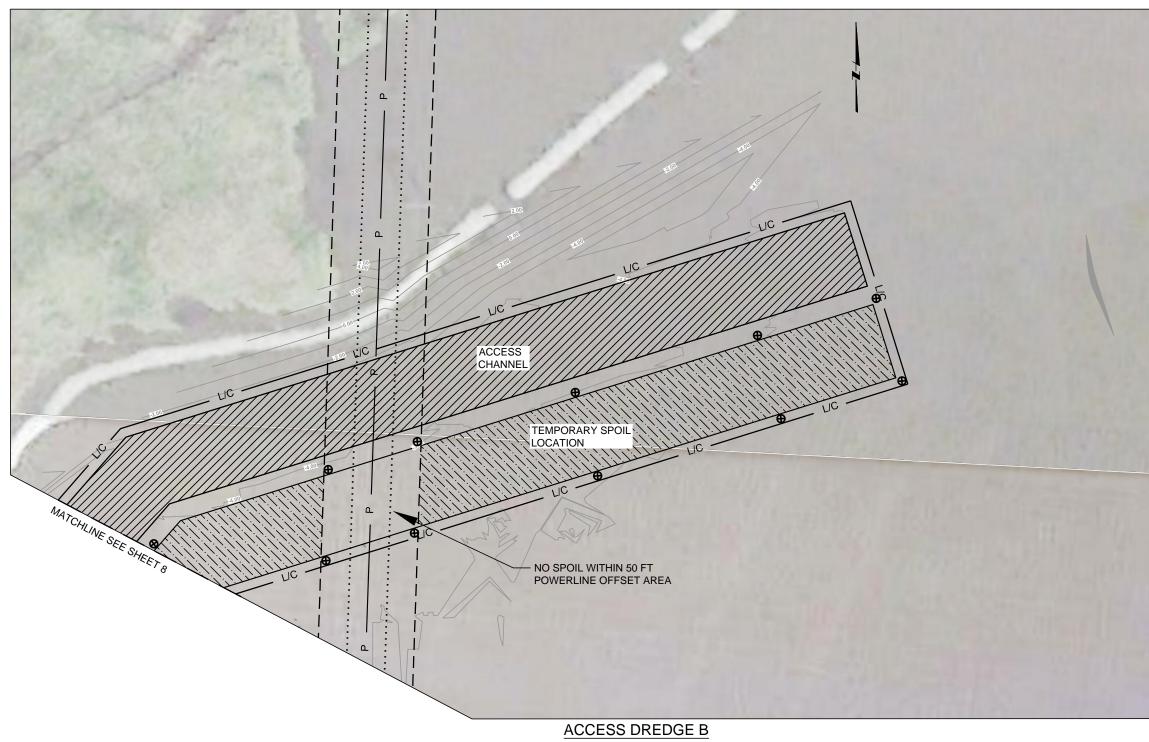
NOTES:


- 1. THE END COORDINATES OF THE PROPOSED ROCK DIKES ARE APPROXIMATE. THE ACTUAL ENDS MAY BE ADJUSTED IN FIELD TO COMPLETELY PROTECT THE SHORE LINE.
- 2. LOCATIONS OF PERMANENT WARNING SIGNS MAY BE ADJUSTED IN THE FIELD BY ENGINEER.


				Stanley Consultants INC.	COASTAL PROTECTION AND RESTORATION AUTHORITY OPERATIONS DIVISION 450 LAUREL STREET, SUITE 1200 BATON ROUGE, LOUISIANA 70801		GIWW TO CLOVELLY HYDROLOGIC RESTORATION 2015 MAINTENANCE PROJECT STATE PROJECT NUMBER: BA-02	ACCESS DREDGE B
F			\square	-	BATON ROUGE, LOUISIANA 70001		FEDERAL PROJECT NUMBER: BA-02	DATE: NOVEMBER 2015
R	EV. DATE	DESCRIPTION	BY	225 Iowa Avenue, Muscatine, Iowa 52761-3764 www.stanleyconsultants.com	DRAWN BY: SRH	DESIGNED BY: SRH	APPROVED BY: JRS	SHEET 9 OF 18


	LEGEND
	EXISTING MARSH BANK
	EXISTING SURFACE CONTOURS
	ROCK DIKE CONTOURS
	ROCK DIKE ALIGNMENT
	SECTION LINES
—Р	POWER LINES
——O——	SURVEYED POWER POLE
	20 FT VERTICAL AND HORIZONTAL CLEARANCE
	50 FT ENTERGY POWER LINE RIGHT OF WAY
L/C	LIMITS OF CONSTRUCTION
•	PERMANENT WARNING SIGNS
8	TEMPORARY WARNING SIGNS
	PROPOSED ACCESS CHANNEL
	TEMPORARY SPOIL LOCATION
	WOODEN CRANE MATS (NO DIRECT PAY)



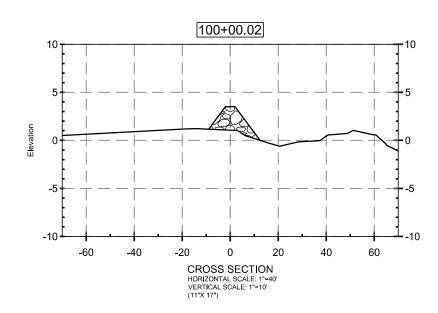

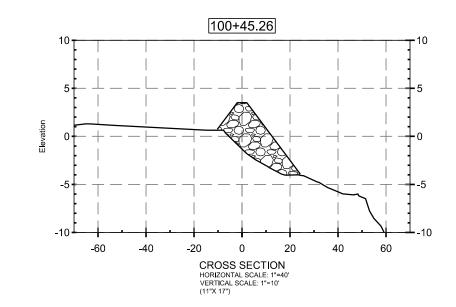

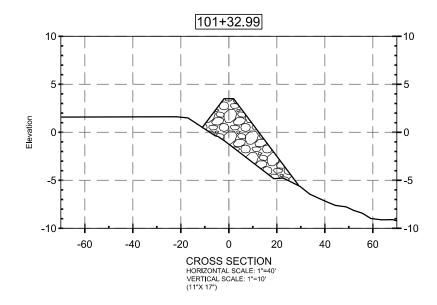

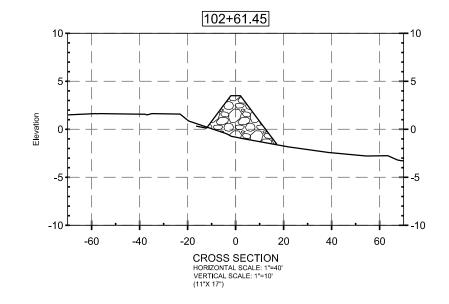


f							D RESTORATION AUTHORITY	
┢	_			\square	Ctoplay Consultants		TREET, SUITE 1200	5
ł	-			\square	Stanley Consultants INC.	BATON ROUGH	E, LOUISIANA 70801	1
F	REV.	DATE	DESCRIPTION	BY	225 Iowa Avenue, Muscatine, Iowa 52761-3764 www.stanleyconsultants.com	DRAWN BY: SRH	DESIGNED BY: SRH	4





EXISTING PROFILE PROPOSED ROCK DIKE PROPOSED EXCAVATION AREA TEMPORARY SPOIL LOCATION

LEGEND

	E OF LOUIS MES R. SMITH INSE NO. 19893 SSIONAL ENGINEER IN
GIWW TO CLOVELLY HYDROLOGIC RESTORATION 2015 MAINTENANCE PROJECT	CROSS SECTIONS A
STATE PROJECT NUMBER: BA-02	
FEDERAL PROJECT NUMBER: BA-02	DATE: NOVEMBER 2015
APPROVED BY: JRS	SHEET 10 OF 18

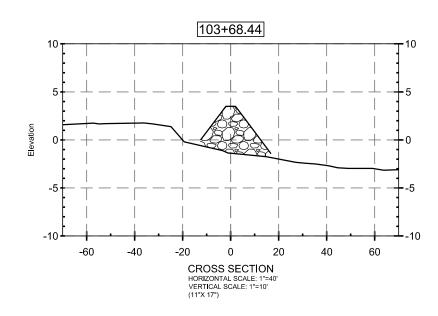

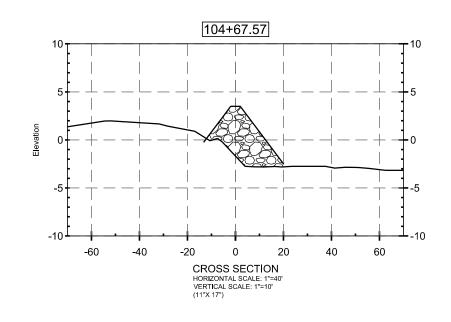


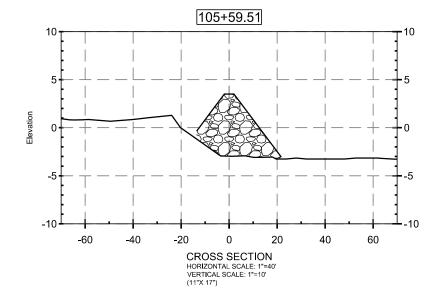


f							D RESTORATION AUTHORITY NS DIVISION	G
ŀ	_						TREET, SUITE 1200	ST
ŀ	_				Stanley Consultants INC.	BATON ROUGE	E, LOUISIANA 70801	FE
F	REV.	DATE	DESCRIPTION	BY	225 Iowa Avenue, Muscatine, Iowa 52761-3764 www.stanleyconsultants.com	DRAWN BY: SRH	DESIGNED BY: SRH	AP



	MES R. SMITH Inse No. 19893 SSIONAL ENGINEER
GIWW TO CLOVELLY HYDROLOGIC RESTORATION 2015 MAINTENANCE PROJECT	CROSS SECTIONS B
STATE PROJECT NUMBER: BA-02	
FEDERAL PROJECT NUMBER: BA-02	DATE: NOVEMBER 2015
APPROVED BY: JRS	SHEET 11 OF 18

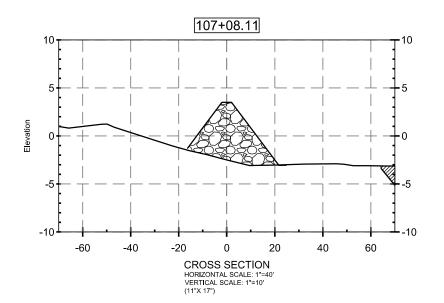

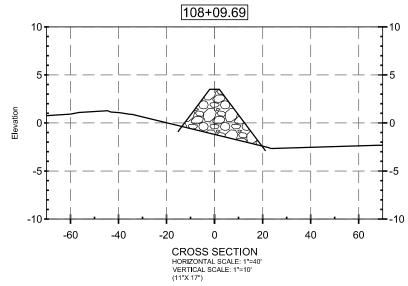



F						D RESTORATION AUTHORITY	GIWW TO CLOVELLY HYDROLOGIC RESTORATION 2015 MAINTENANCE PROJECT	CROSS SECTIONS C
┢			\square	Stonley Consultants	450 LAUREL STREET. SUITE 1200		STATE PROJECT NUMBER: BA-02	
ŀ	+			Stanley Consultants INC.	BATON ROUGE	, LOUISIANA 70801	FEDERAL PROJECT NUMBER: BA-02	DATE: NOVEMBER 2015
F	EV. DATE	DESCRIPTION	BY	225 Iowa Avenue, Muscatine, Iowa 52761-3764 www.stanleyconsultants.com	DRAWN BY: SRH	DESIGNED BY: SRH	APPROVED BY: JRS	SHEET 12 OF 18

EXISTING PROFILE PROPOSED ROCK DIKE PROPOSED EXCAVATION AREA TEMPORARY SPOIL LOCATION

LEGEND

	ES R. SMITH IES R. SMITH ISSIONAL ENGINEER
PROLOGIC RESTORATION ANCE PROJECT	CROSS SECTIONS C

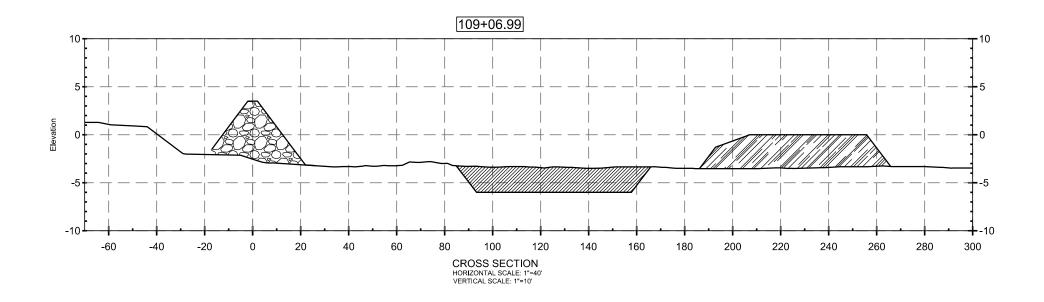


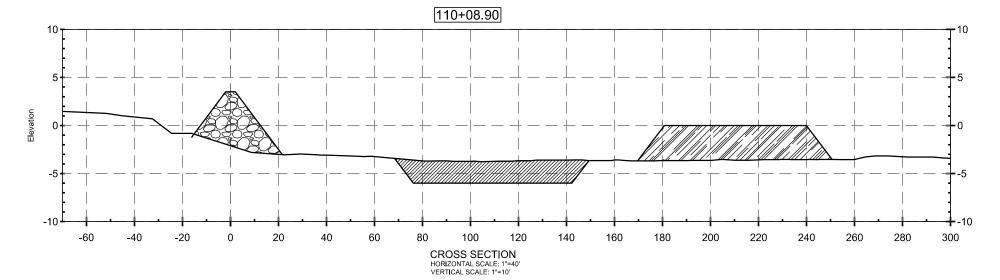






AND	AES R. SMITH INSE NO. 19893 SSIONAL ENGINEER
GIWW TO CLOVELLY HYDROLOGIC RESTORATION 2015 MAINTENANCE PROJECT	CROSS SECTIONS D
STATE PROJECT NUMBER: BA-02	
FEDERAL PROJECT NUMBER: BA-02	DATE: NOVEMBER 2015
APPROVED BY: JRS	SHEET 13 OF 18

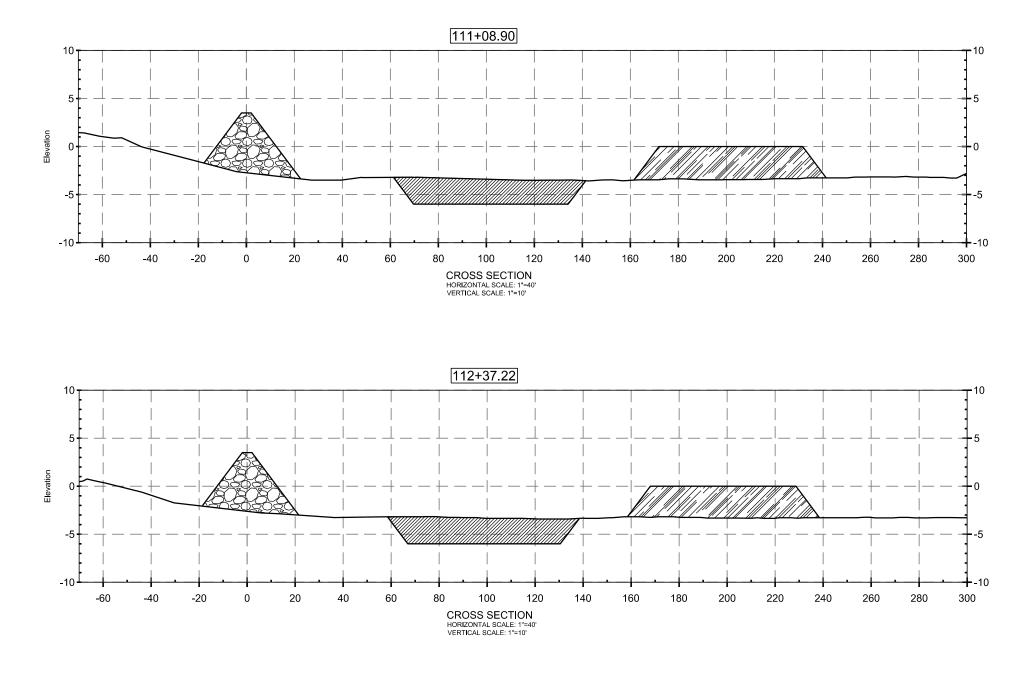






JAN PROFI	AES R. SMITH Inse No. 19893 SSIONAL ENGINEER
GIWW TO CLOVELLY HYDROLOGIC RESTORATION 2015 MAINTENANCE PROJECT	CROSS SECTIONS E
STATE PROJECT NUMBER: BA-02	
FEDERAL PROJECT NUMBER: BA-02	DATE: NOVEMBER 2015
APPROVED BY: JRS	SHEET 14 OF 18

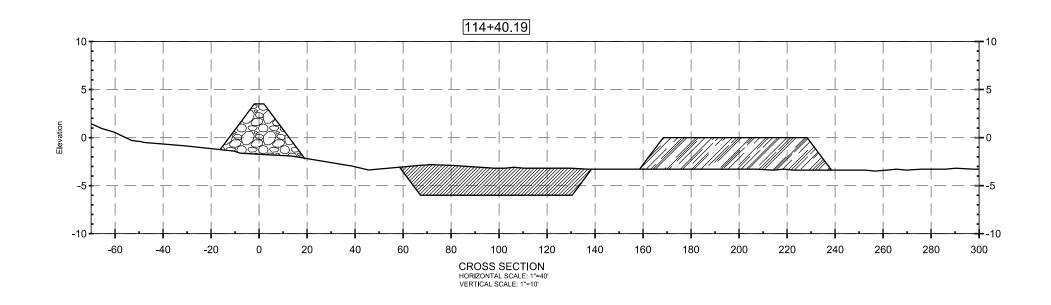


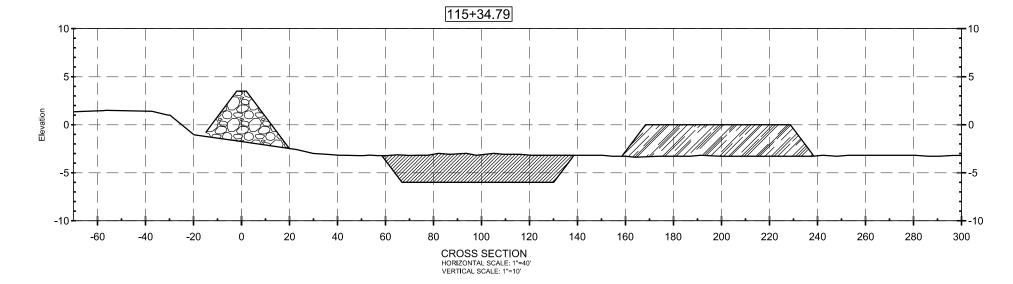

E							D RESTORATION AUTHORITY	G
┝	_						TREET, SUITE 1200	ST
ŀ	-			\square	Stanley Consultants INC.	BATON ROUGE	E, LOUISIANA 70801	FF
F	REV.	DATE	DESCRIPTION	BY	225 Iowa Avenue, Muscatine, Iowa 52761-3764 www.stanleyconsultants.com	DRAWN BY: SRH	DESIGNED BY: SRH	Ał




	NES R. SMITH IES R. SMITH SSIONAL ENGINEER
GIWW TO CLOVELLY HYDROLOGIC RESTORATION 2015 MAINTENANCE PROJECT	CROSS SECTIONS F
STATE PROJECT NUMBER: BA-02	
FEDERAL PROJECT NUMBER: BA-02	DATE: NOVEMBER 2015
APPROVED BY: JRS	SHEET 15 OF 18

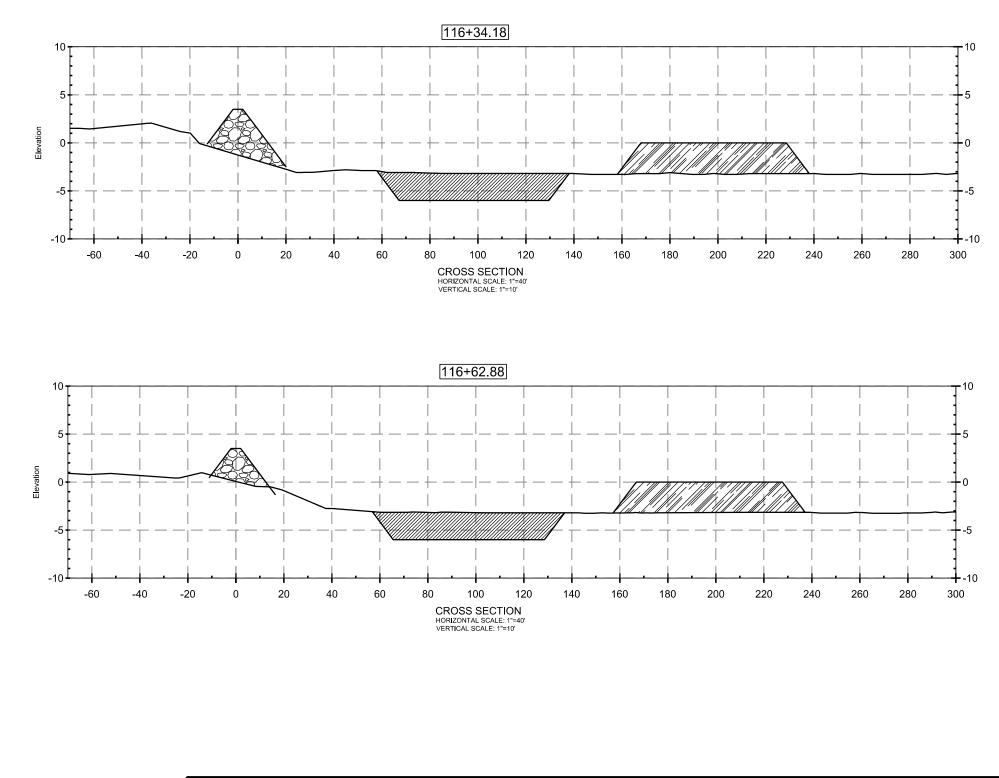



					Stanley Consultants INC. 225 Iowa Avenue, Muscatine, Iowa 52761-3764	OPERATIO 450 LAUREL ST	COASTAL PROTECTION AND RESTORATION AUTHORITY OPERATIONS DIVISION 450 LAUREL STREET, SUITE 1200 BATON ROUGE, LOUISIANA 70801		
L	_ I				225 Iowa Avenue Muscatine Iowa 52761-3764				
F	REV.	DATE	DESCRIPTION	BY	www.stanleyconsultants.com	DRAWN BY: SRH	DESIGNED BY: SRH		




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GIWW TO CLOVELLY HYDROLOGIC RESTORATION 2015 MAINTENANCE PROJECT	CROSS SECTIONS G	
STATE PROJECT NUMBER: BA-02		
STATE PROJECT NUMBER: BA-02 FEDERAL PROJECT NUMBER: BA-02	DATE: NOVEMBER 2015	

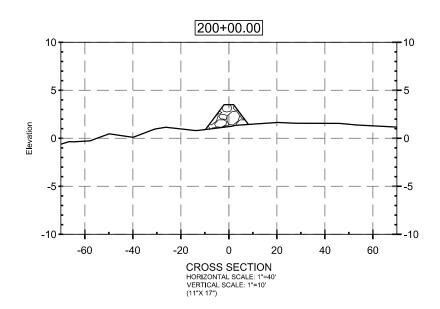

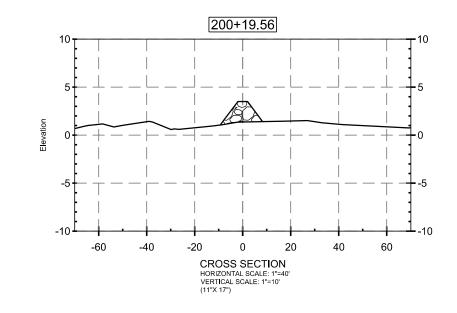

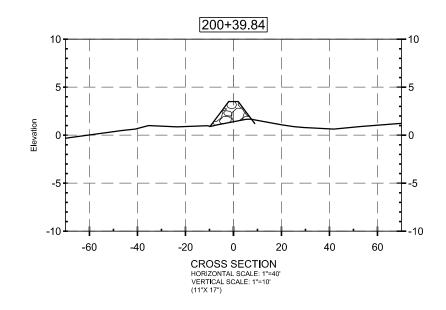


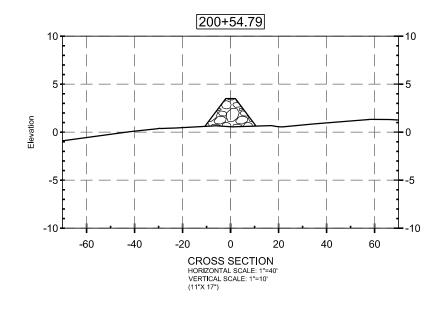

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			\vdash			TREET, SUITE 1200	5
┢			\vdash	Stanley Consultants INC.	BATON ROUGE	E, LOUISIANA 70801	1
RE	V. DATE	DESCRIPTION	BY	225 Iowa Avenue, Muscatine, Iowa 52761-3764 www.stanleyconsultants.com	DRAWN BY: SRH	DESIGNED BY: SRH	1




	AES R. SMITH Inse No. 19893 SSIONAL ENGINEER	
GIWW TO CLOVELLY HYDROLOGIC RESTORATION 2015 MAINTENANCE PROJECT	CROSS SECTIONS H	
STATE PROJECT NUMBER: BA-02		
FEDERAL PROJECT NUMBER: BA-02	DATE: NOVEMBER 2015	
APPROVED BY: JRS	SHEET 17 OF 18	

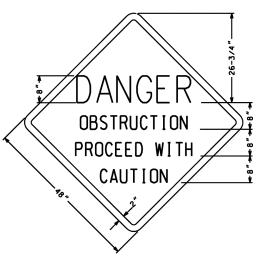


NOTES:

- 1. CONTRACTOR TO REMOVE AND PROPERLY DISPOSE OF SUBSTRUCTURES FOLLOWING APPLICABLE LAWS.
- 2. ALL 3/4" DIAMETER ALL-THREAD TIE RODS SHALL BE SECURED BY NOTCHED IN PLACE OGEE WASHERS AND TACK WELDED NUTS.
- 3. GALVANIZED WOOD PILE CAPS SHALL BE INSTALLED ON EACH PILE AT STRUCTURE .
- 4. THE TOP OF THE PILES SHALL BE COATED WITH COAL TAR EPOXY PAINT PRIOR TO PLACING CAP.

NOTES:

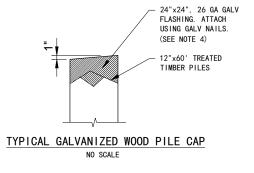

				Stanley Consultants INC. 225 Iowa Avenue, Muscatine, Iowa 52761-3764	COASTAL PROTECTION AND RESTORATION AUTHORITY OPERATIONS DIVISION 450 LAUREL STREET, SUITE 1200 BATON ROUGE, LOUISIANA 70801	
REV.	DATE	DESCRIPTION	BY	www.stanleyconsultants.com	DRAWN BY: SRH	DESIGNED BY: SRH

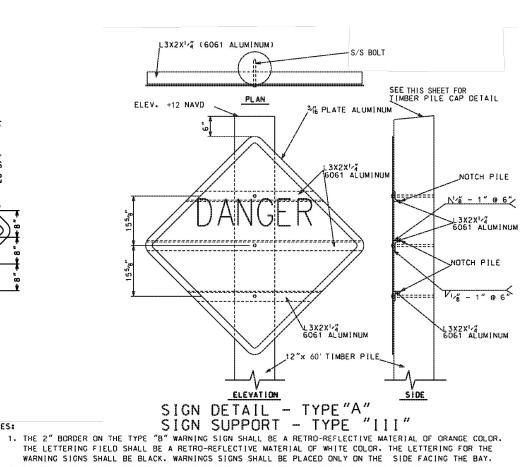

2. NEOPRENE OR TEFLON WASHERS SHALL BE PLACED BETWEEN STEEL ANGLE AND ALUMINUM SIGNS.

	SR. SMITH Se No. 19893 NONAL ENGINEER
GIWW TO CLOVELLY HYDROLOGIC RESTORATION 2015 MAINTENANCE PROJECT	NAVIGATIONAL AID DETAILS
STATE PROJECT NUMBER: BA-02	DETAILS
FEDERAL PROJECT NUMBER: BA-02	DATE: NOVEMBER 2015